GENERAL LEGEND

PROPOSED DESCRIPTION PROPERTY LINES SETBACK LINES CENTERI INF \dots STOCKADE FENCE SOIL BOUNDARY FASEMENT MAJOR CONTOUR
MINOR CONTOUR
EDGE OF PAVEMENT
VERTICAL GRANITE CURB VGC SLOPE GRANITE CURB CAPE COD BERM
POURED CONCRETE CURB
SILT FENCE DRAINAGE LINE SEWER LINE SEWER FORCE MAIN GAS LINE WATER LINE WATER SERVICE OVERHEAD ELECTRIC UNDERGROUND ELECTRIC GUARDRAIL

100×0 × 100.00 × 100.00 99.50 × 100.00 99.50 0.0

KXXXX

XXXXX

* * *

FRESHWATER WETLANDS LINE TIDAL WETLANDS LINE STREAM CHANNEL

UNDERDRAIN FIRE PROTECTION LINE
THRUST BLOCK
IRON PIPE/IRON ROD
DRILL HOLE IRON ROD /DRILL HOLE SPOT GRADE
PAVEMENT SPOT GRADE

CURB SPOT GRADE BENCHMARK (TBM) DOUBLE POST SIGN SINGLE POST SIGN

MONITORING WELL PERC TEST PHOTO LOCATION TREES AND RUSHES UTILITY POLE

WATER GATE WATER SHUT OFF REDUCER
SINGLE GRATE CATCH BASIN
DOUBLE GRATE CATCH BASIN CULVERT W/WINGWALLS
CULVERT W/FLARED END SECTION
CULVERT W/STRAIGHT HEADWALL
STONE CHECK DAM

DRAINAGE FLOW DIRECTION 4K SEPTIC AREA

WETLAND IMPACT

VEGETATED FILTER STRIP RIPRAP

OPEN WATER FRESHWATER WETLANDS

TIDAL WETLANDS STABILIZED CONSTRUCTION

CONCRETE GRAVEL


SNOW STORAGE RETAINING WALL

COMMERCIAL SITE PLAN "VENTURE POWERSPORTS" **TAX MAP 220, LOT 50** 7 TOLEND ROAD, BARRINGTON, NH

SHEET INDEX

COVER SHEET C1 EXISTING CONDITIONS PLAN C2 SITE PLAN C3 GRADING AND DRAINAGE PLAN C4 UTILITY PLAN L1 LIGHTING PLAN L2 LANDSCAPE PLAN D1 **DETAIL SHEET** FLOOR PLAN A2 ARCHITECTURAL ELEVATIONS

EROSION AND SEDIMENT CONTROL DETAILS

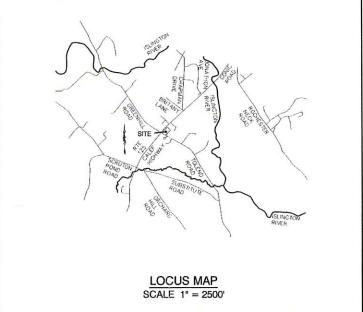

PURPOSE OF PLAN: SEE SHEET C2 TAX MAP 220, LOT 50 AREA OF SUBJECT PARCEL: SEE BELOW ZONING DESIGNATION: SEE SHEET C1 ZONING REQUIREMENTS: SEE SHEET C1 PROPOSED USE: SEE SHEET C2 PARKING REQUIREMENTS: SEE SHEET C2 LOT COVERAGE: SEE SHEET C2 SANITARY SEWER SOURCE: ON-SITE SEPTIC SYSTEM WATER SUPPLY SOURCE: ON-SITE WELL ZONING VARIANCES: NONE FLOODPLAIN INFORMATION: SEE SHEET CI STATE PERMITS REQUIRED: NONE
PLANNING BOARD WAIVERS: NONE REQUESTED

- IF. DURING CONSTRUCTION, IT BECOMES APPARENT THAT DEFICIENCES EXIST IN THE APPROVED DESIGN DRAWINGS. THE OWNER SHALL BE REQUIRED TO CORRECT THE DEFICIENCIES TO MEET THE REQUIREMENTS OF THE REGULATIONS AT NO EXPENSE TO THE TOWN.
- IF. DURING CONSTRUCTION, IT BECOMES APPARENT THAT ADDITIONAL F, Boding Control Measures are required to stop any erosion on the Construction sitedue to actual site conditions, the owner shall be required to install the necessary erosion protection AT NO EXPENSE TO THE TOWN.
- ALL MATERIALS AND METHODS OF CONSTRUCTION SHALL CONFORM TO OWN REGULATIONS AND THE LATEST EDITION OF THE NEW HAMP DEPARTMENT OF TRANSPORTATION'S STANDARD SPECIFICATIONS FOR ROAD AND BRIDGE CONSTRUCTION

CONDITIONS OF APPROVAL

THIS IS TO INFORM YOU THAT THE BARRINGTON PLANNING BOARD AT ITS MAY 4, 2021 MEETING CONDITIONALLY APPROVED YOUR APPLICATION REFERENCED ABOVE.

ALL OF THE PRECEDENT CONDITIONS BELOW MUST BE MET BY THE APPLICANT, AT THE EXPENSE OF THE APPLICANT, PRIOR TO THE PLANS BEING CERTIFIED BY THE PLANNING BOARD. CERTIFICATION OF THE PLANS IS REQUIRED PRIOR TO COMMENCEMENT OF ANY SITE WORK OR RECORDING OF ANY PLANS. ONCE THESE PRECEDENT CONDITIONS ARE MET AND THE PLANS ARE CERTIFIED THE APPROVAL IS CONSIDERED FINAL

PLEASE NOTE* IF ALL OF THE PRECEDENT CONDITIONS ARE NOT MET WITHIN 6 CALENDAR MONTHS TO THE DAY, BY NOVEMBER 4, 2021, THE BOARDS APPROVAL WILL BE CONSIDERED TO HAVE LAPSED, UNLESS A MUTUALLY AGREEABLE EXTENSION HAS BEEN GRANTED BY THE BOARD.

CONDITIONS PRECEDENT

- 1) ADD THE FOLLOWING PLAN NOTES
 - WASTE OIL WILL BE DISPOSED OF ACCORDING TO DES STANDARDS.
 - FUEL WILL BE STORED IN APPROVED CONTAINERS.
 - VEGETATIVE BUFFER MUST BE MAINTAINED ALONG THE PROPERTY LINE
 - REVISE SHEET C4 NOTE 8 AS-BUILT PLANS SHALL BE SUBMITTED TO THE
- 2) REVISE THE FOLLOWING PLAN NOTES

A) ADD THE NHDES SUBSURFACE BUREAU C.A. #158476

- 3) ALL ISSUES FROM D&K ADDRESSED.
- #4) ANY OUTSTANDING FEES SHALL BE PAID TO THE TOWN.
- PRIOR TO OBTAINING BOARD SIGNATURE, THE APPLICANT SHAIL SUBMIT THREE(3) COMPLETE PAPER PRINT PLAN SETS AND SUPPORTING DOCUMENTS AS REQUIRED IN ARTICLE 3 WITH A LETTER EXPLAINING HOW THE APPLICANT ADDRESSED THE CONDITIONS OF APPROVAL. THIS SHALL INCLUDE FINAL AND COMPLETE REPORTS FOR ALL ITEMS SUBMITTED DURING REVIEW FOR THE TOWN OF BARRINGTON'S FILE. THE CHAIRMAN SHALL ENDORSE THREE COPIES OF THE APPROVED PLAN(S) MEETING THE CONDITIONS OF APPROVAL, THE TOWN SHALL RETAIN A SIGNED AND APPROVED REPRODUCIBLE 11"X17", AND PDF FORMAT WITH SUPPORTING

GENERAL AND SUBSEQUENT CONDITIONS

#1) WHERE NO ACTIVE AND SUBSTANTIAL WORK, REQUIRED UNDER THIS APPROVAL HAS COMMENCED UPON THE SITE WITHIN TWO YEARS FROM THE DATE THE PLAN IS SIGNED, THIS APPROVAL SHALL EXPIRE. AN EXTENSION, NOT TO EXCEED ONE YEAR, MAY BE GRANTED, B' MAJORITY YOTE OF THE BOARD SO LONG AS IT IS APPLIED FOR AT LEAST THIRTY DAYS PRIOR TO THE EXPIRATION DATE. THE BOARD MAY GRANT ONLY ONE SUCH EXTENSION FOR ANY PROPOSED SITE PLAN. ALL OTHER PLANS MUST BE SUBMITTED TO THE BOARD FOR REVIEW TO ENSURE COMPLIANCE WITH THESE AND OTHER TOWN ORDINANCES. ACTIVE AND SUBSTANTIAL WORK IS DEFINED IN THIS SECTION AS BEING THE EXPENDITURE OF AT LEAST 25% OF THE INFRASTRUCTURE IMPROVEMENTS REQUIRED UNDER THIS APPROVAL INFRASTRUCTURE SHALL MEAN IN THIS INSTANCE, THE CONSTRUCTION OF ROADS, STORM DRAINS, AND IMPROVEMENTS INDICATED ON THE SITE PLAN, RSA 674:39

(NOTE: IN BOTH SECTIONS ABOVE, THE NUMBERED CONDITION MARKED WITH A # AND ALL CONDITIONS BELOW THE# ARE STANDARD CONDITIONS ON ALL OR MOST APPLICATIONS OF THIS TYPE).

TAX MAP 220 TAX MAP 220 LOT 50 SUBJECT LOT

VICINITY MAP SCALE 1" = 250 CIVIL ENGINEER / SURVEYOR JONES & BEACH ENGINEERS, INC. 85 PORTSMOUTH AVENUE PO BOX 219 STRATHAM, NH 03885 (603) 772-4746 CONTACT: JOSEPH CORONATI EMAIL: JCORONATI@JONESANDBEACH.COM

WETLAND CONSULTANT GOVE ENVIRONMENTAL SERVICES, INC. 8 CONTINENTAL DR., BUILDING 2, UNIT H EXETER, NH 03833-7526 (603) 778-0644 CONTACT: JAMES GOVE

ELECTRIC EVERSOURCE 74 OLD DOVER ROAD ROCHESTER, NH 03867 (603) 332-4227

TELEPHONE

FAIRPOINT COMMUNICATIONS 100 TRI CITY ROAD

SOMERWORTH, NH 03878 PLANNING BOARD ATTN:DAVE KESTNER (603) 743-1114

CABLE TV METROCAST CORPORATION
21 JARVIS AVE.FILE NUMBER

ROCHESTER, NH 03868 (603) 335-4106

TOTAL LOTATEAN AN

 Design:
 JAC
 Draft:
 DJM
 Date:
 10/30/20


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 Scale:
 AS NOTED
 Project No.: 20656.1
 Drawing Name: 20656-PLAN.dwg THIS PLAN SHALL NOT BE MODIFIED WITHOUT WRITTEN ANY ALTERATIONS, AUTHORIZED OR OTHERWISE, SHALL BE

AT THE USER'S SOLE RISK AND WITHOUT LIABILITY TO JBE.


5	6/1/21	REVISED PER CONDITIONS OF APPROVAL	DJM
4	4/9/21	REVISED PER ENGINEERING AND PLANNING DEPT COMMENTS	DJM
3	3/29/21	REVISED PER ENGINEERING COMMENTS	DJM
2	3/11/21	REVISED PER PLANNING BOARD COMMENTS	DJM
1	2/9/21	ISSUED FOR REVIEW	DJM
REV.	DATE	REVISION	BY

Jones & Beach Engineers, Inc. 85 Portsmouth Ave. Civil Engineering Services FAX: 603-772-0227 E-MAIL: JBE@JONESANDBEACH.COM

COVER SHEET Plan Name **VENTURE POWERSPORTS** Project: 7 TOLEND ROAD, BARRINGTON, NH PEH AND SON, LLC 17 DUDLEY ROAD, BRENTWOOD, NH 03833 BK 4855 PG 0723

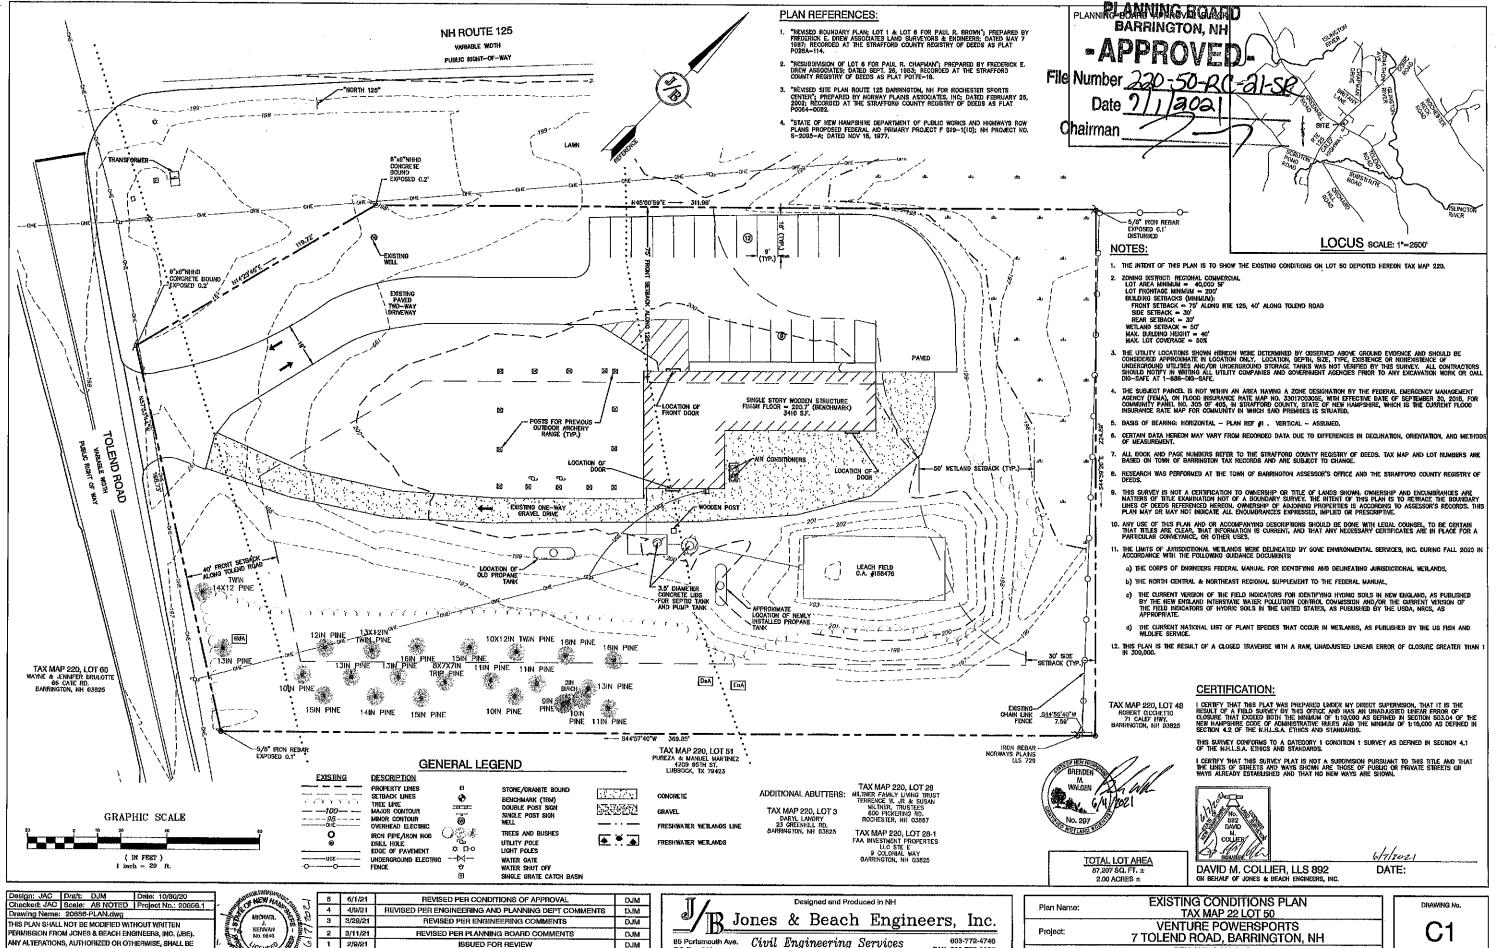


NY ALTERATIONS, AUTHORIZED OR OTHERWISE, SHALL BE AT THE USER'S SOLE RISK AND WITHOUT LIABILITY TO JOE,

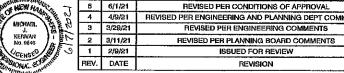

85 Portsmouth Ave. Civil Engineering Services PO Box 219 Stratham, NH 03885

E-MAIL: JBE@JONESANDBEACH.COM

PEH AND SON, LLC Owner of Record: 17 DUDLEY ROAD, BRENTWOOD, NH 03833 BK 4855 PG 0723

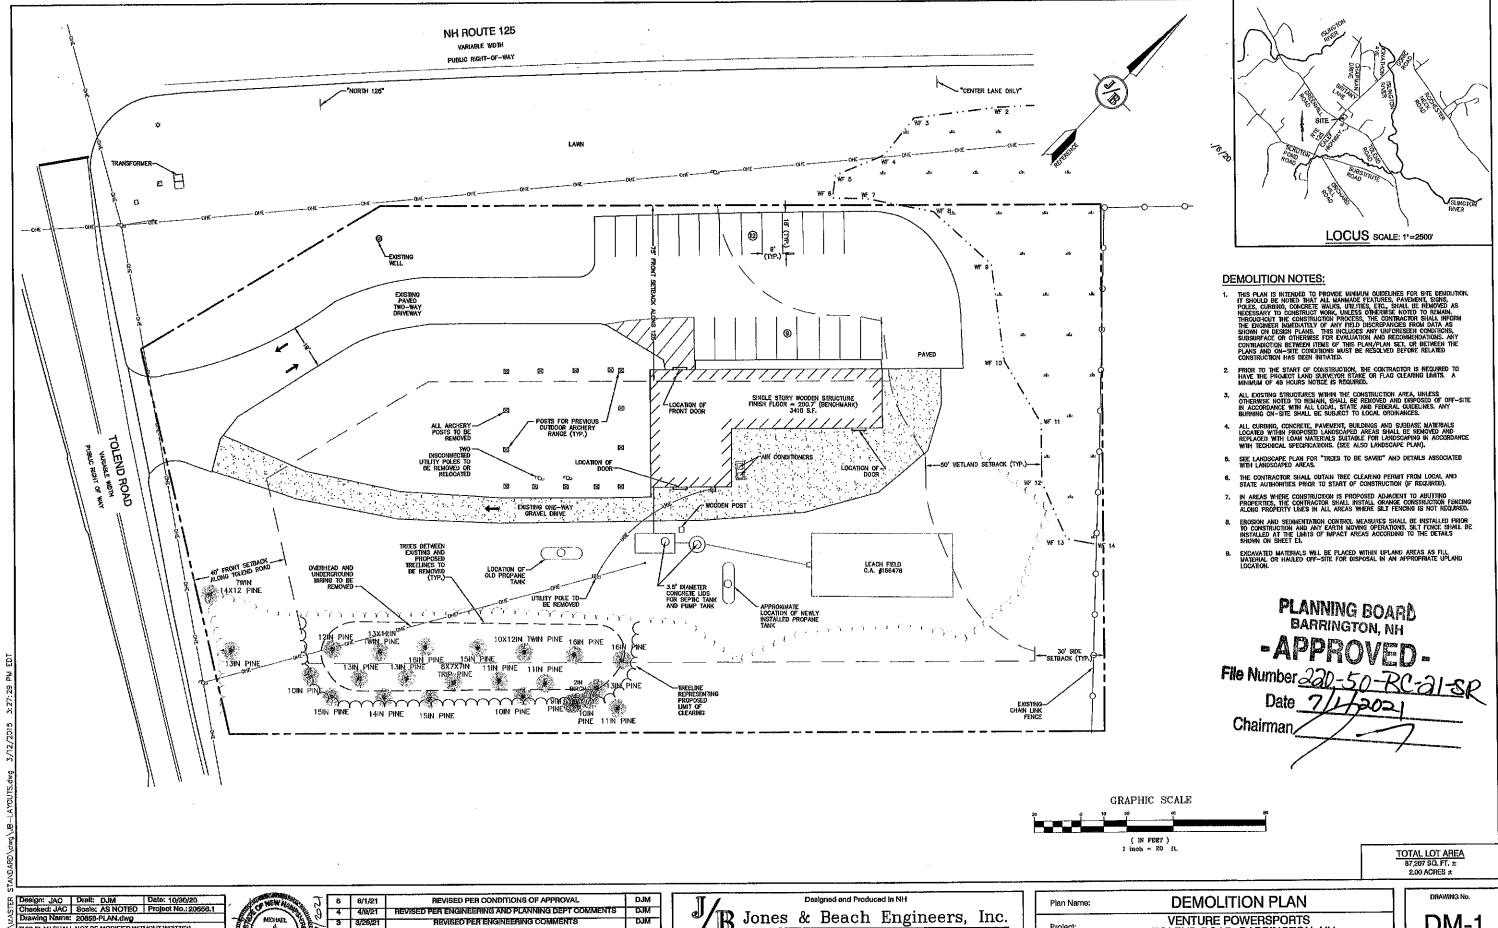

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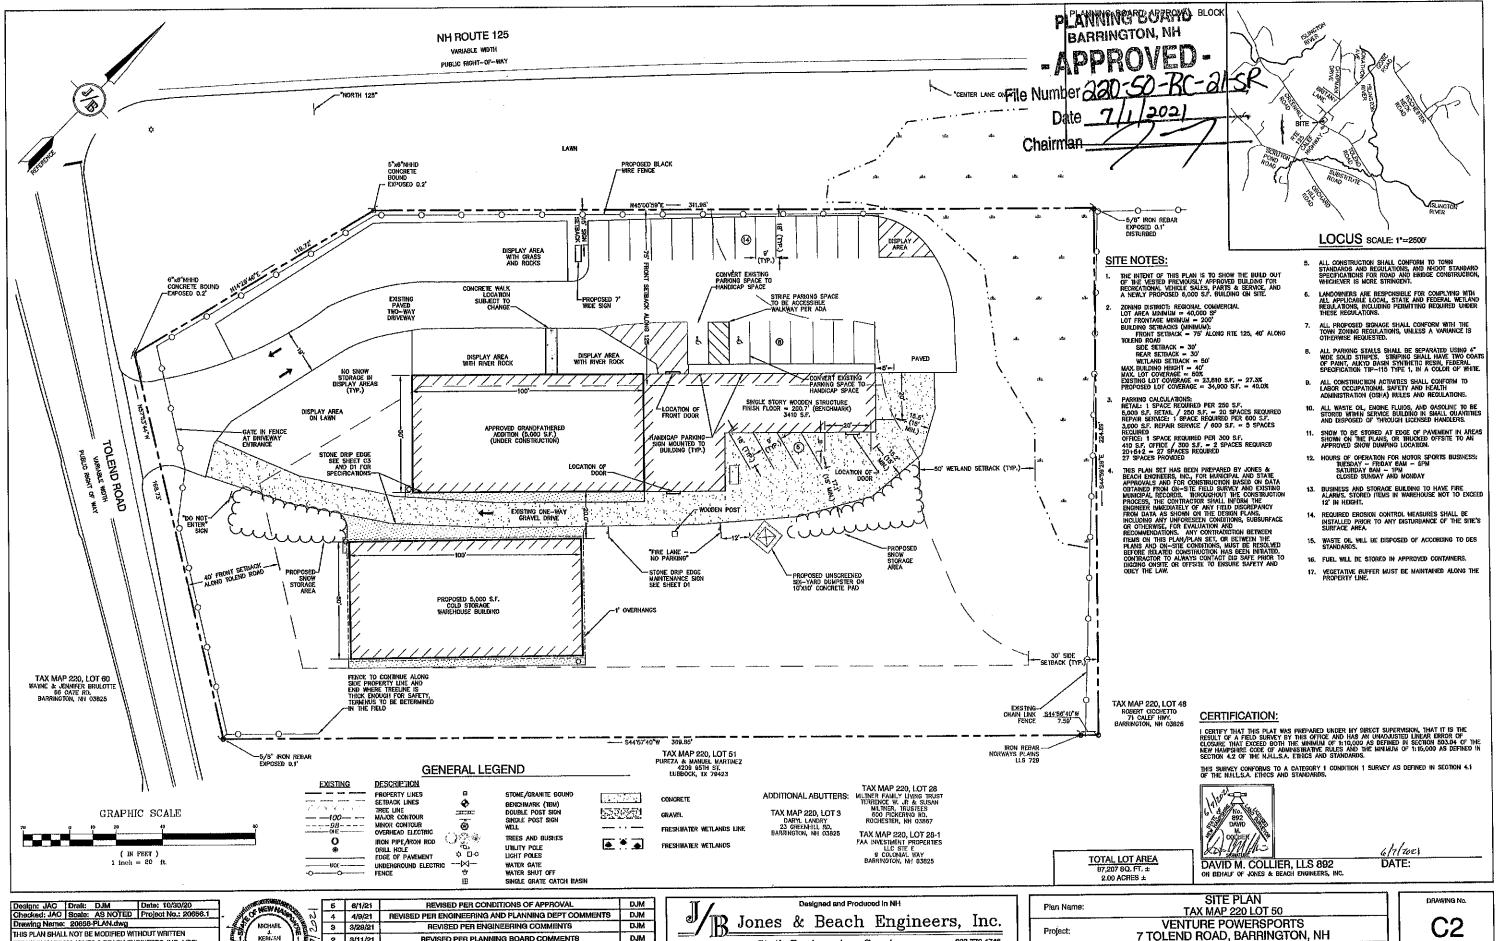
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17 /		Designed and Produ		
I JR J	ones	& Beach	Engineers,	Inc.
85 Portsmouth Ave. PO Box 219 Strethern, NH 03885	Civil	Engineering	Semires 600	3-772-474 6 3-772-0227


~~~		10012, 1110.	Project
ering	Services	603-772-4746 FAX: 603-772-0227	<u> </u>
	E-MAIL: JBE@	JONESANDBEACH.COM	Owner

Plan Name:	DEMOLITION PLAN
Project:	VENTURE POWERSPORTS 7 TOLEND ROAD, BARRINGTON, NH
Owner of Record:	PEH AND SON, LLC 17 DUDLEY ROAD, BRENTWOOD, NH 03833 BK 4855 PG 0723

DM-1 SHEET 3 OF 12 JBE PROJECT NO. 20656.1



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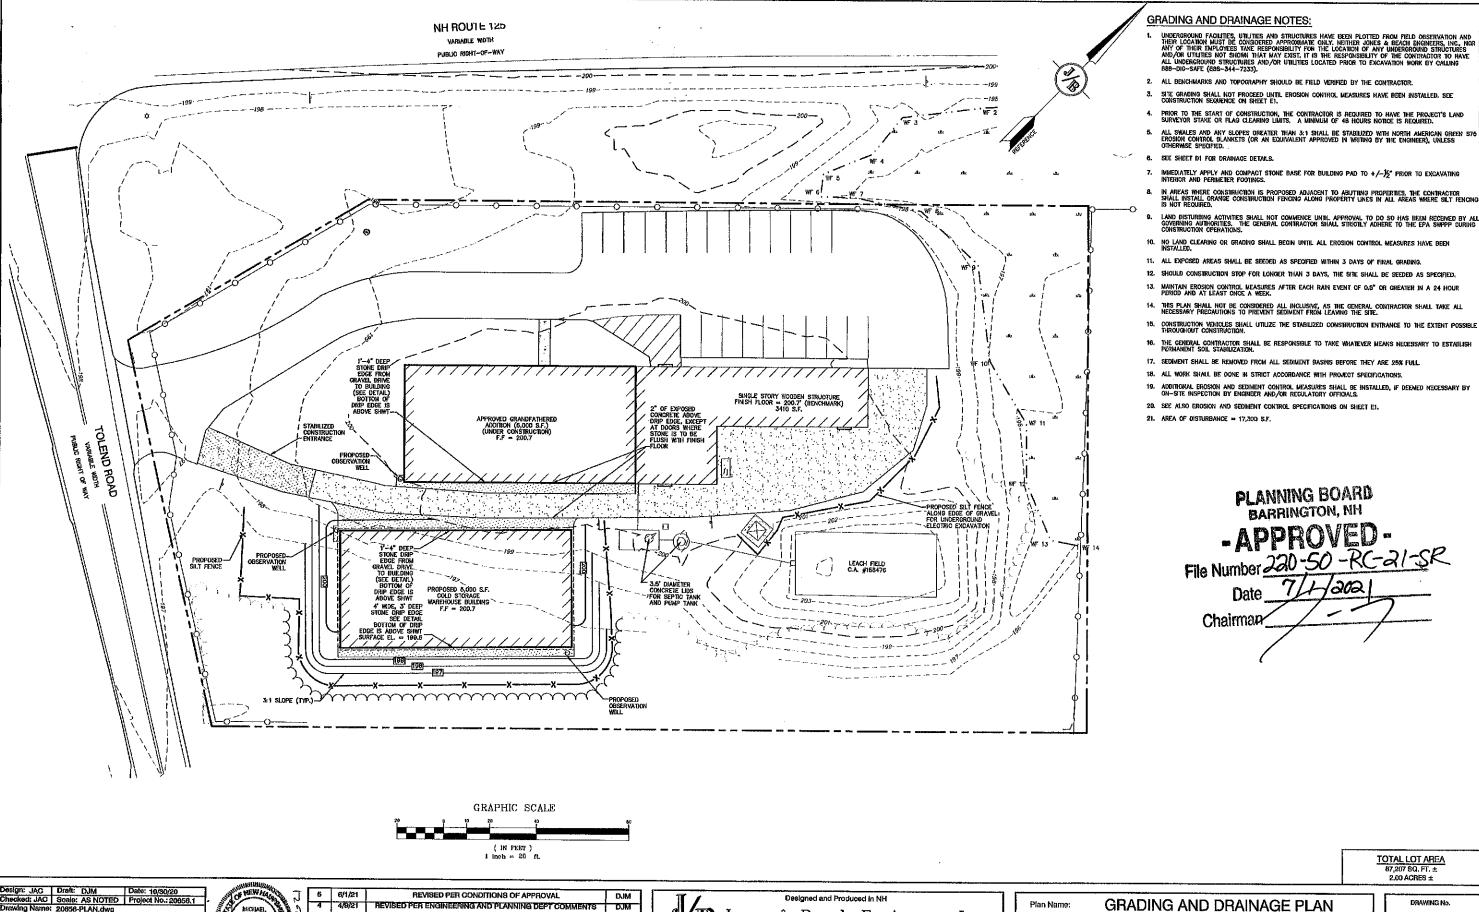
603-772-4746

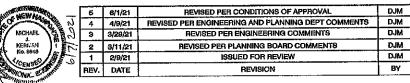85 Portsmouth Ave. Civil Engineering Services Detrutues
FAX: 603-772-0227
E-MAIL: JBE@JONESANDBEACH.COM PO Box 219 Stretham, NH 03885

7 TOLEND ROAD, BARRINGTON, NH PEH AND SON, LLC 17 DUDLEY ROAD, BRENTWOOD, NH 03833 BK 4855 PG 0723 Owner of Record:

SHEET 4 OF 12

JBE PROJECT NO. 20656.1



Jones & Beach Engineers, Inc. 3 3/29/21 REVISED PER ENGINEERING COMMENTS DJM 2 3/11/21 REVISED FER PLANNING BOARD COMMENTS DJM Project: 85 Portsmouth Ave. PO Box 219
Stratham, NH 03885

Civil Engineering Services
E-MAIL: JBEG Services 603-772-4746 FAX: 603-772-0227 E-MAIL: JBE@JONEBANDBEACH.COM 1 2/9/21 ISSUED FOR REVIEW DJM REV. DATE REVISION BY Owner of Record:


THIS PLAN SHALL NOT BE MODIFIED WITHOUT WRITTEN PERMISSION FROM JONES & BEACH ENGINEERS, INC. (JBE).

ANY ALTERATIONS, AUTHORIZED OR OTHERWISE, SHALL BE

AT THE USER'S SOLE FISK AND WITHOUT LIABILITY TO JBE.

VENTURE POWERSPORTS
7 TOLEND ROAD, BARRINGTON, NH
PEH AND SON, LLC
17 DUDLEY ROAD, BRENTWOOD, NH 03833 BK 4855 PG 0723

8HEET 5 OF 12 JBE PROJECT NO. 20856.1

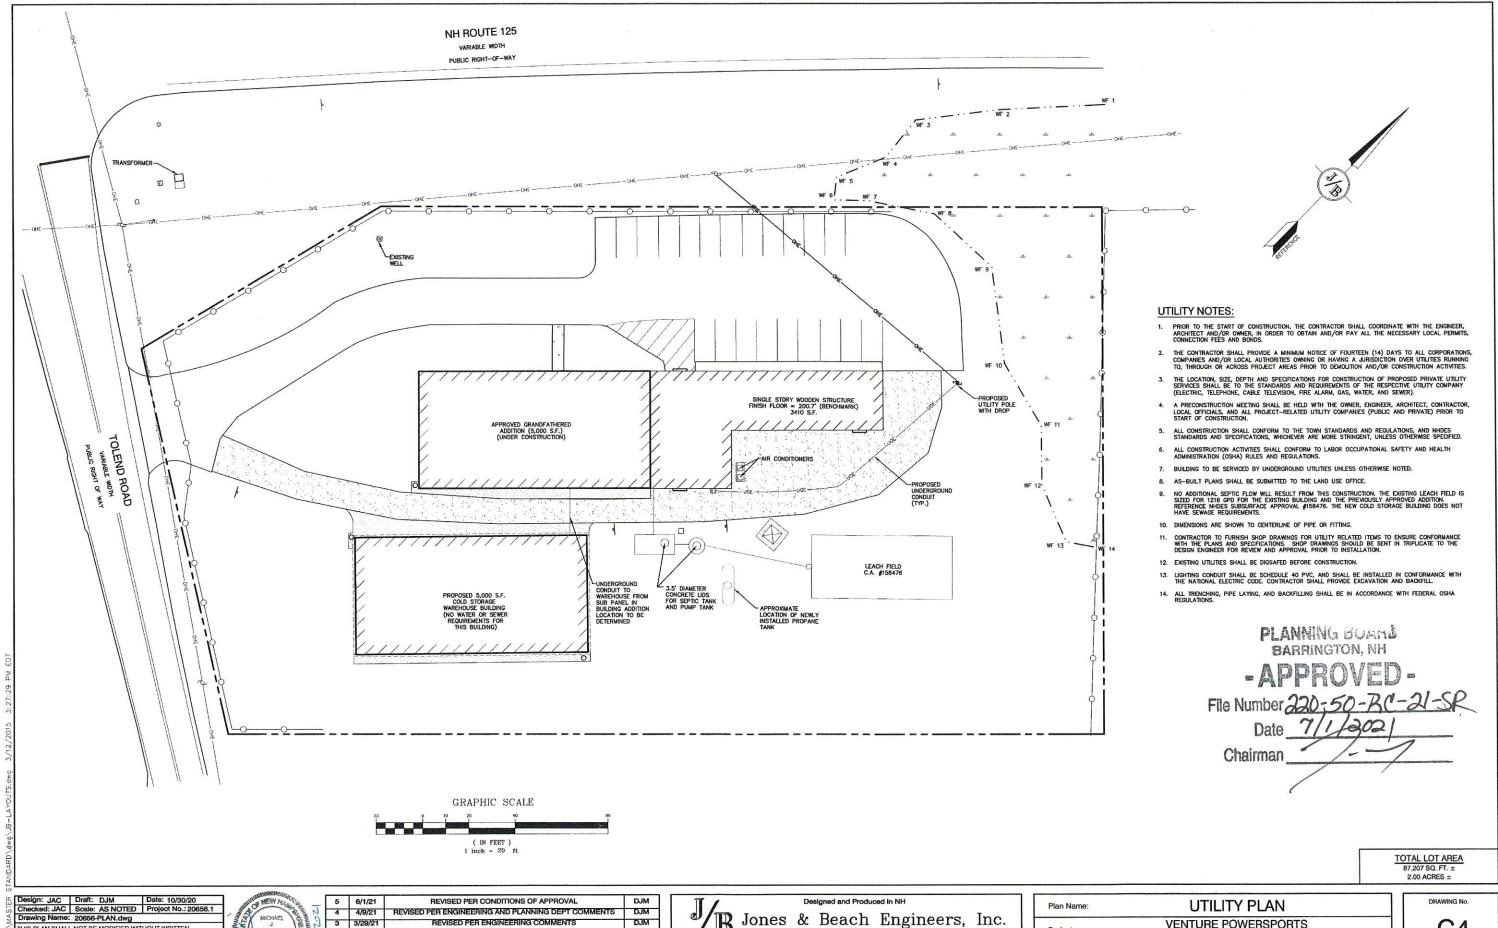

Checked: JAC Scale: AS NOTED Project No.: 20656.1

Drawing Name: 20656-PLAN.dwg

THIS PLAN SHALL NOT BE MODIFIED WITHOUT WRITTEN
PERMISSION FROM JONES & BEACH ENGINEERS, INC. (JBE).

ANY ALTERATIONS, AUTHORIZED OR OTHERWISE, SHALL BE
AT THE USER'S SOLE RISK AND WITHOUT LIABILITY TO JBE.



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3	3	3/29/21	REVISED PER ENGINEERING COMMENTS	DJM
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9	1	2/9/21	ISSUED FOR REVIEW	DJM
	REV.	DATE	REVISION	BY

Designed and Produced in NH


Jones & Beach Engineers, Inc.

B5 Portsmouth Ave. Civil Engineering Services FAX: 603-772-4746
PO Box 219
Stratham, NH 03885

E-MAIL: JBE@JONESANDBEACH.COM

Plan Name: UTILITY PLAN				
Project:	VENTURE POWERSPORTS 7 TOLEND ROAD, BARRINGTON,	NH		
Owner of Record:	PEH AND SON, LLC 17 DUDLEY ROAD, BRENTWOOD, NH 03833	BK 4855 PG 0723		

SHEET 6 OF 12
JBE PROJECT NO. 20656.1

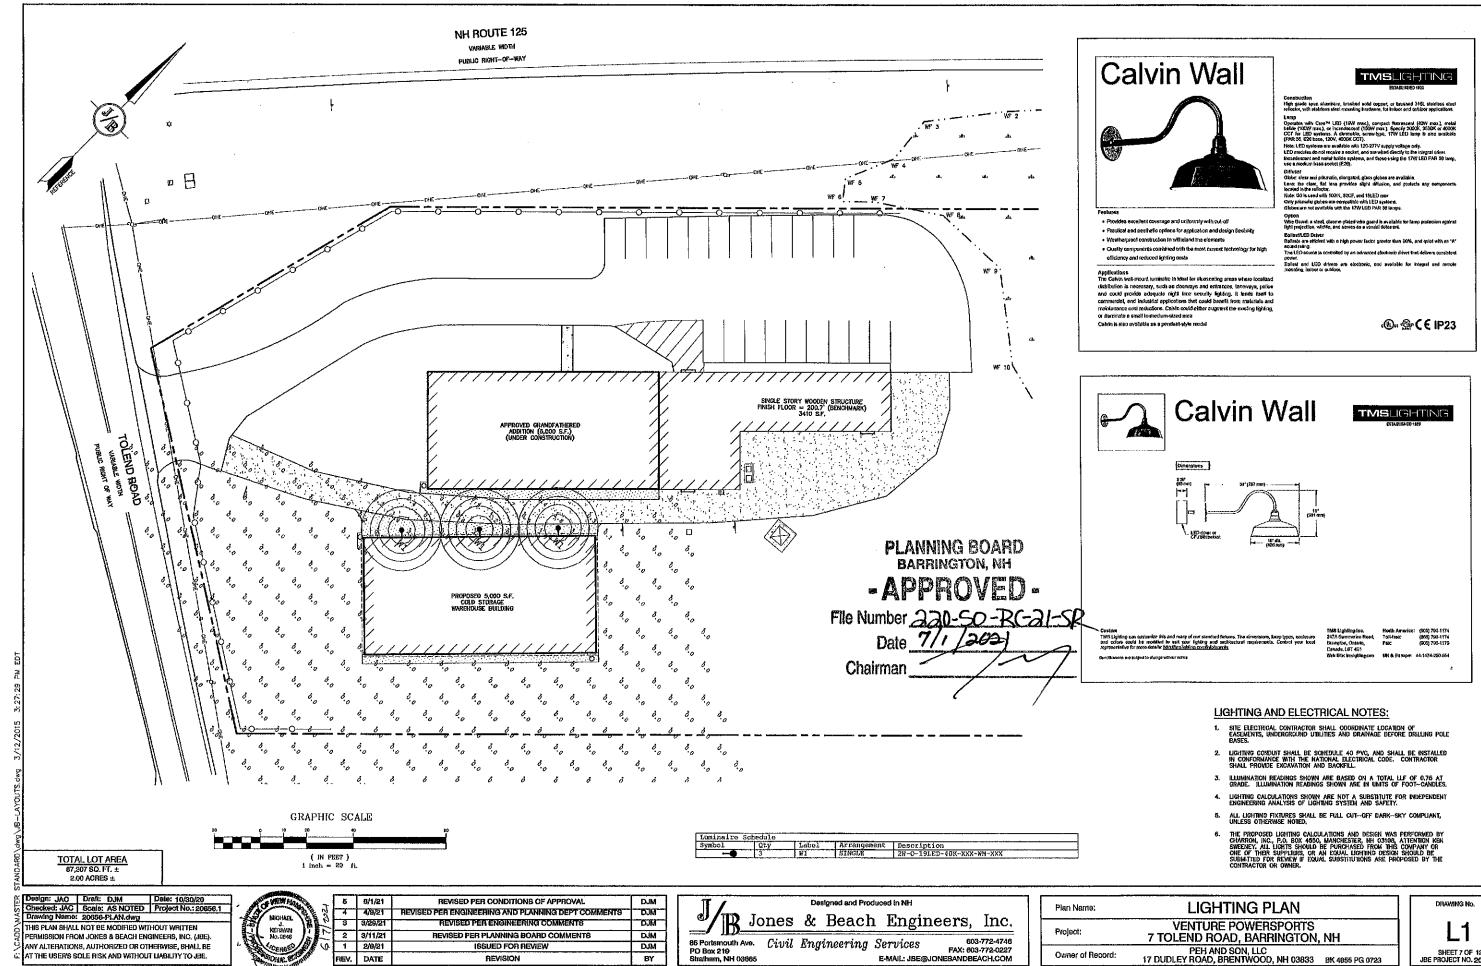

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ANY ALTERATIONS, AUTHORIZED OR OTHERWISE, SHALL BE

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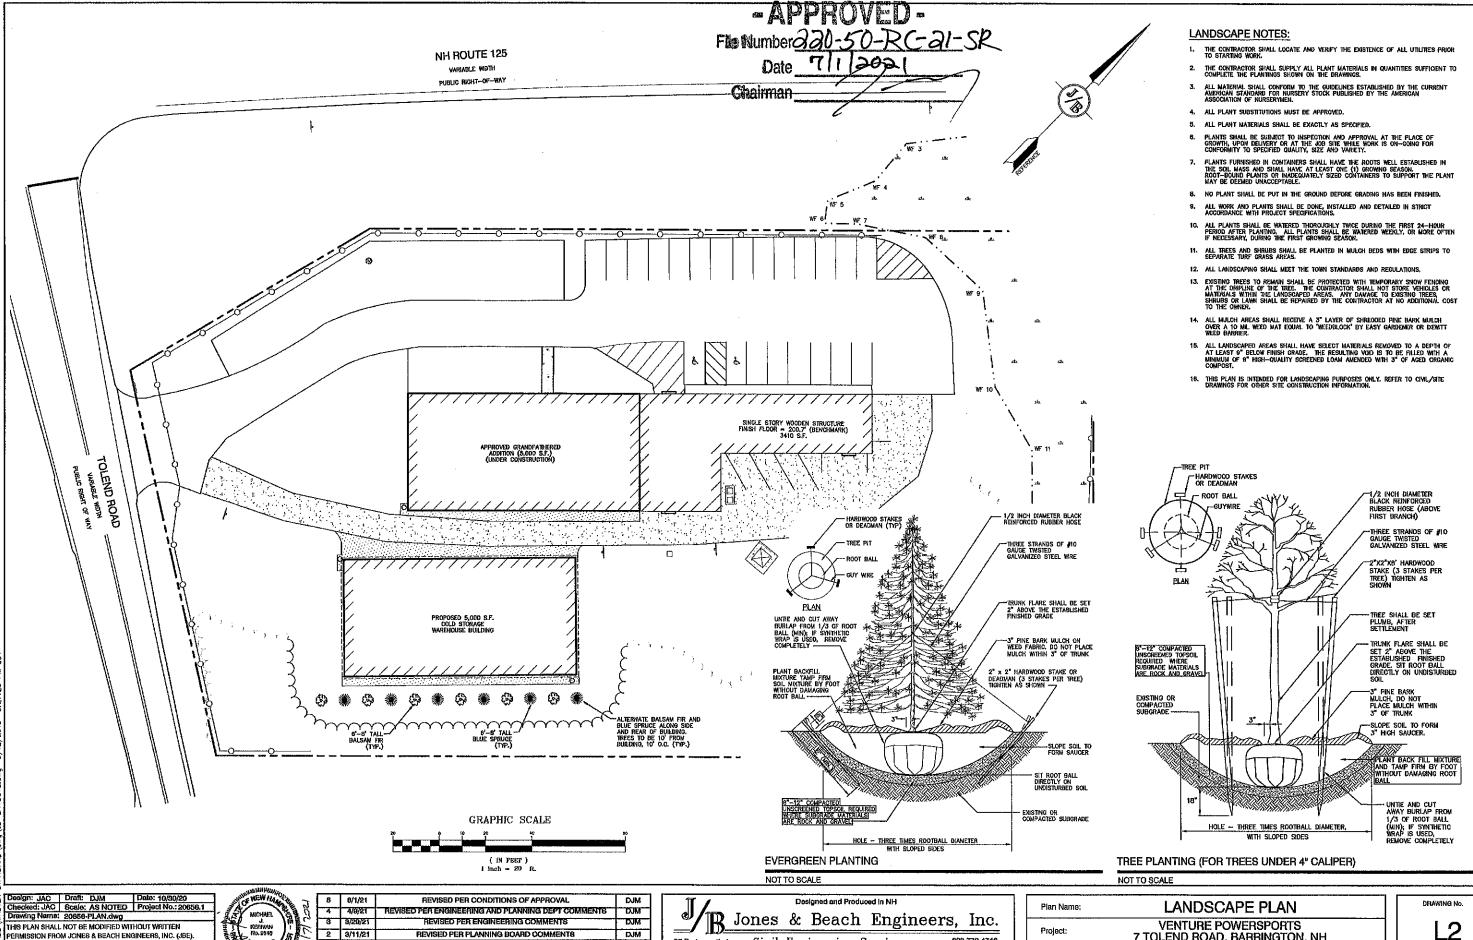
603-772-4746

Owner of Record:

Setvices 603-772-4746 FAX: 603-772-0227 E-MAIL: JBE@JONESANDBEACH.COM

SHEET 7 OF 12 JBE PROJECT NO. 20866.

PEH AND SON, LLC 17 DUDLEY ROAD, BRENTWOOD, NH 03833 BK 4855 PG 0723



ANY ALTERATIONS, AUTHORIZED OR OTHERWISE, SHALL BE AT THE USER'S SOLE RISK AND WITHOUT LIABILITY TO JIBE.


MICHAEL J. Keriyan No. 0848 2 3/11/21 REVISED PER PLANNING BOARD COMMENTS 1 2/9/21 ISSUED FOR REVIEW DJM BY REV. DATE REVISION

Civil Engineering Services 603-772-4746

FAX: 603-772-0227 E-MAIL: JBE@JONESANDBEACH.COM


Plan Name;	LANDSCAPE PLAN	
Project:	VENTURE POWERSPORTS 7 TOLEND ROAD, BARRINGTON,	NH
Owner of Record:	PEH AND SON, LLC 17 DUDLEY BOAD, BRENTWOOD, NH 03833	BK 4855 PG O

**L2** SHEET 6 OF 12 JBE PROJECT NO. 20656

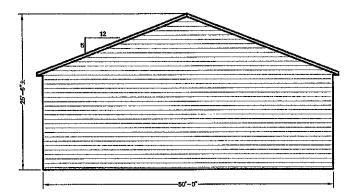


# SOUTHWEST ELEVATION

1/8" = 1'-0"

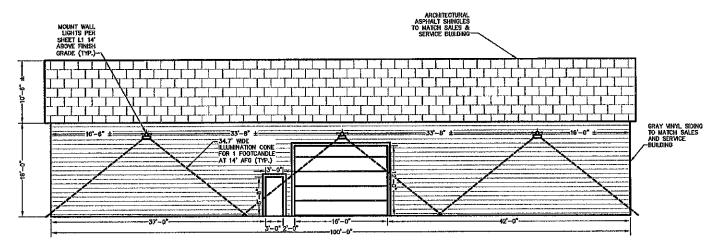

NORTHWEST ELEVATION

1/8" = 1'-0"

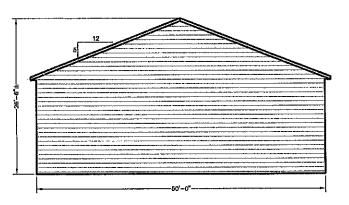


BARRINGTON, No

- APPROVED File Number 220-50-BC-21-SP
Date 7/1/2021

Chairman <

NORTHEAST ELEVATION

1/8" = 1'-0"

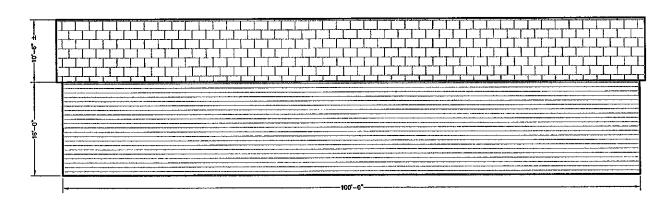

SOUTHEAST ELEVATION

1/8" = 1'-0"

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F	REV.	DATE	REVISION	BY



Plan Name;	ARCHITECTURAL ELEVATIONS
Project:	VENTURE POWERSPORTS 7 TOLEND ROAD, BARRINGTON, NH
Owner of Record:	PEH AND SON, LLC 17 DUDLEY ROAD, BRENTWOOD, NH 03833 BK 4855 PG 0723


**A2** SHEET 11 OF 12 JBE PROJECT NO. 20656.1

TEMPORARY EROSION CONTROL NOTES

1. THE SMALLEST PRACTICAL AREA OF LAND SHALL BE EXPOSED AT ANY ONE TIME. AT NO TIME SHALL AN AREA IN EXCESS OF 5
ACRES DE EXPOSED AT ANY ONE TIME BEFORE DISTRIBED AREAS ARE STABILIZED.

- erosion, sediment and detention measures shall be installed as shown on the plans and at locations as required, directed by the engineer,
- ALL DISTURBED AREAS (INCLUDING POND AREAS BELOW THE PROPOSED WATERLINE) SHALL BE RETURNED TO PROPOSED GRADES AND ELEVATIONS, IS INSTRUBED AREAS SHALL BE LOAMED WITH A MINIMUM OF 6° OF SCREENED ORGANIC LOAM AND SEEDED WITH SEED MIXTURE 'C' AT A RATE MOT LESS THAN 1.10 POUNDS OF SEED PR 1,000 SF. OF AREA (48 LBS. / ACRE).
- SILT FENCES AND OTHER BARRIERS SHALL BE INSPECTED EVERY SEVEN CALENDAR DAYS AND WITHIN 24 HOURS OF A RAINFALL OF 0.5° OR GREATER. ALL DAMAGED AREAS SHALL BE REPAIRED, AND SEDIMENT DEPOSITS SHALL PERIODICALLY BE REMOVED AND DISPOSED OF.
- AFTER ALL DISTURBED AREAS HAVE BEEN STABILIZED, THE TEMPORARY EROSION CONTROL MEASURES SHALL BE REMOVED AND THE AREA DISTURBED BY THE REMOVAL SMOOTHED AND RE-VEGETATED.
- ALL PROPOSED VEGETATED AREAS THAT DO NOT EXHIBIT A MINIMUM OF 85 PERCENT VEGETATIVE GROWTH BY OCTOBER 15, CR WHICH ARE DISTURBED AFTER COTOBER 16, SHALL BE STABILIZED BY SEEDING AND INSTALLING NORTH AMERICAN GREEN 575 REDISTOR CONTROL BLANKETS (OR AN EQUIVALENT APPROVED IN WITHING BY THE INGINEERS) ON EPOCES GREATER THAM 571, AND SEEDING AND PILACING 3 TO 4 TONS OF MULCH PER ACRE, SECURED WITH ANCHORED NETTING, ELSEWHERE, THE INSTALLATION OF EROSION CONTROL BLANKETS OR MULCH AND NETTING SHALL NOT OCCUR OVER ACCUMULATED SHOW OR ON FROZEN GROUND AND SHALL BE COMPLETED IN ADVANCE OF THAW OR SPRING MELT VENTS.
- ALL DITCHES OR SWALES WHICH DO NOT EXHIBIT A MINIMUM OF 85 PERCENT VEGETATIVE GROWTH BY OCTOBER 15, OR WHICH ARE DISTURBED AFTER OCTOBER 15, SHALL BE STABILIZED TEMPORARILY WITH STONE OR EROSION CONTROL BLANKETS APPROPRIATE FOR THE DESIGN FLOW CONDITIONS.
- AN AREA SHALL BE CONSIDERED STABLE IF ONE OF THE FOLLOWING HAS OCCURRED:
  - BASE COURSE GRAVELS HAVE BEEN INSTALLED IN AREAS TO BE PAVED
  - b. A MINIMUM OF 85% VEGETATED GROWTH HAS BEEN ESTABLISHED
  - c. A MINIMUM OF 3" OF NON-EROSIVE MATERIAL SUCH STONE OR RIPRAP HAS BEEN INSTALLED; OR


PLANNING BOARD BARRINGTON, NH -APPROVED-File Number 220-50-RC-21-58
Date 7/1/2021 Chairman

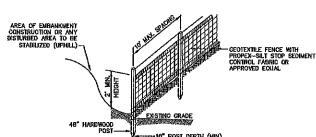

# CONSTRUCTION SPECIFICATIONS:

- WOVEN FABRIC FENCE TO BE FASTENED SECURELY TO FENCE POSTS WITH WIRE TIES OR STAPLES. FILTER CLOTH SHALL BE FASTENED TO WOVEN WIRE EVERY  $24^{\circ}$  AT TOP, MID AND BOTTOM AND EMBEDDED IN THE GROUND A MINIMUM OF  $8^{\circ}$  AND THEN COVERED WITH SOIL.
- THE FENCE POSTS SHALL BE A MINIMUM OF 48" LONG, SPACED A MAXIMUM 10' APART, AND ORIVEN MINIMUM OF 18" INTO THE GROUND.
- . When two sections of filter cloth adjoin each other, the ends of the fabric shall be overlapped by, folded and stapled to prevent sediment from by-passing.
- . Maintenance shall be performed as needed and sediment removed and properly disposed of when it is 6° deep or visible 'bulges' develop in the silt fence.
- 5. PLACE THE ENDS OF THE SILT FENCE UP CONTOUR TO PROVIDE FOR SEDIMENT STORAGE.
- B. SILT FENCE SHALL REMAIN IN PLACE FOR 24 MONTHS

SILT FENCE NOT TO SCALE

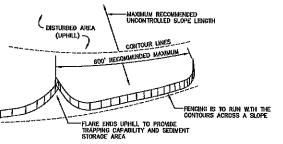

7. SILT FENCES SHALL BE REMOVED WHEN NO LONGER NEEDED AND THE SEDMENT COLLECTED SHALL BE DISPOSED AS DISFORTED BY THE ENGINEER. THE AREA DISTURBED BY THE REMOVAL SHALL BE SMOOTHED AND REVECTATED.

- 1, SILT FENCES SHALL BE INSPECTED IMMEDIATELY AFTER EACH RAINFALL AND AT LEAST DAILY DURING PROLONGED RAINFALL. ANY REPAIRS THAT ARE REQUIRED SHALL BE DONE IMMEDIATELY.
- IF THE FABRIC ON A SILT FENCE SHOULD DECOMPOSE OR BECOME INEFFECTIVE DURING THE EXPECTED LIFE OF THE FENCE, THE FABRIC SHALL BE REPLACED PROMPTLY.
- 3. SEDIMENT DEPOSITS SHOULD BE INSPECTED AFTER EVERY STORM EVENT. THE DEPOSITS SHOULD BE REMOVED WHEN THEY REACH APPROXIMATELY ONE HALF THE HEIGHT OF THE BARRIER.
- 4. SEDIMENT DEPOSITS THAT ARE REMOVED, OR LEFT IN PLACE AFTER THE FABRIC HAS BEEN REMOVED, SHALL BE GRADED TO CONFORM WITH THE EXISTING TOPOGRAPHY AND VEGETATED.

# SEEDING SPECIFICATIONS

- Gradnic and Shaping

  A. Slopes Shall not be steeper 'Than 2:1 without appropriate erosion control measures as specified on the plans (3:1 slopes or flatter are preferred).

  B. Where Mowing Will be done, 3:1 slopes or flatter are recommended,

- 2. SEEDBED PREPARATION

  A. SURFACE AND SEEPAGE WATER SHOULD BE DRAINED OR DIVERTED FROM THE SITE TO PREVENT DROWNING OR WINTER KILLING OF THE PLANTS.

  B. STONES LARGER THAN 4 INCHES AND TRASH SHOULD BE REMOVED BECAUSE THEY INTERFERE WITH SEEDING AND FUTURE MAINTENANCE OF THE AREA. WHERE FEASIBLE, THE SOIL SHOULD BE TILLED TO A DEPTH OF ABOUT 4 INCHES TO PREPARE A SEEDBED AND FERTILIZER AND LIME MOZED INTO THE SOIL. THE SEEDBED SHOULD BE LIFT IN A REASONABLY RINK AND SMOTH CONDITION, THE LAST TILLAGE OPERATION SIGNING BY PREFORMED ACROSS THE SLOPE WHEREVER PRACTICAL.

- 3. ESTABLISHING A STAND.

  A. LIME AND FERTILIZER SHOULD BE APPLIED PRIOR TO OR AT THE TIME OF SEEDING AND INCORPORATED INTO THE SOIL. TYPES AND AMOUNTS OF LIME AND FERTILIZER SHOULD BE BASED ON AN EVALUATION OF SOIL TESTS. WHEN A SOIL TEST IS NOT AVAILABLE, THE FOLLOWING MINIMUM AMOUNTS SHOULD BE
  - APPLICE:
    APPLICED:
    APPLICE
  - (NOTE: THIS IS THE EQUIVALENT OF 500 LBS, PER ACRE OF 10-20-20 FERTILIZER OR 1,000 LBS, PER
- SEED SHOULD BE SPREAD UNIFORMLY BY THE METHOD MOST APPROPRIATE FOR THE SITE, METHODS INCLIDE BROADDASTING, DRILLING AND HYDROSEEDING, WHERE BROADCASTING IS USED, COVER SEED WITH 125 INCH OF SOIL OR LESS, BY CULTIPACKING OR RAKING.

  REFER TO THE "SEEDING GUIDE" AND "SEEDING RATES" TABLES ON THIS SHEET FOR APPROPRIATE, SEED
- MIXTURES AND RATES OF SEEDING. ALL LEGINES (CROMINETCH, BIRDSFOOT, TREFOIL AND FLATTER)
  MUST BE INDOCULATED WITH HERE SPECIFIC INDOCULANT PRORT TO THEIR INTRODUCTION TO THE SITE.

  O. WHEN SECOED AREAS ARE MULCHED, PLANTINGS MAY BE MADE FROM EARLY SPRING TO EARLY OCTOBER
  WHEN SECOED AREAS ARE NOT MULCHED, PLANTINGS SHOULD BE MADE FROM EARLY SPRING TO MAY 2C
  OR FROM AUGUST 10th TO SEPTEMBER 18t.

ANY, STRAW, OR OTHER MALCH, WHEN NEEDED, SHOULD BE APPLIED IMMEDIATELY AFTER SEEDING.

B. MULCH WILL BE HELD IN PLACE USING APPROPRIATE TECHNIQUES FROM THE BEST MANAGEMENT PRACTICE FOR MULCHING. HAY OR STRAW MULCH SHALL BE PLACED AT A RAYE OF 90 LBS PER 1000 S.F.

- 5. MAINTENANCE TO ESTABLISH A STAND.

  A. PLANTED AREAS SHOULD BE PROTECTED FROM DAMAGE BY FIRE, GRAZING, TRAFFIC, AND DENSE WEED
- GROWTH.

  B. FERRILIZATION NEEDS SHOULD BE DETERMINED BY CHSITE INSPECTIONS. SUPPLEMENTAL FERTILIZER IS
  USUALLY THE KEY TO FULLY COMPLETE THE ESTABLISHMENT OF THE STAND BECAUSE MOST PERENNIALS
  TAKE 2 TO 3 YEARS TO BECOME FULLY ESTABLISHED.

  C. IN WATERWAYS, CHAMILES, OR SHALES WHERE UNIFORM FLOW CONDITIONS ARE ANTICIPATED, ANNUAL
  MOWING MAY BE NECESSARY TO CONTROL GROWTH OF WOODY VEGETATION.

USE	SEEDING MIXTURE 1/	DROUGHTY	WELL DRAINED	MODERATELY WELL DRAINED	POORLY DRAINED
STEEP CUTS AND FILLS, BORROW AND DISPOSAL AREAS	A B C	FAIR POOR POOR	GOOD GOOD	GOOD FAIR EXCELLENT	FAIR FAIR GOOD
Miche	D	FAIR	EXCELLENT	EXCELLENT	POOR
WATERWAYS, EMERGENC SPILLWAYS, AND OTHER CHANNELS WITH FLOWING WATER.		GOOD	GOOD EXCELLENT	GOOD EXCELLENT	FAIR FAIR
LIGHTLY USED PARKING LOTS, ODD AREAS, UNUSED LANDS, AND LOW INTENSITY USE RECREATION SITES.	A B C	GOOD GOOD GOOD	GOOD GOOD EXCELLENT	GOOD FAIR EXCELLENT	FAIR POOR FAIR
PLAY AREAS AND ATHLETIC FIELDS, (TOPSOIL IS ESSENTIAL FOR GOOD TURF.)	E F	FAIR FAIR	EXCELLENT	EXCELLENT EXCELLENT	2/2 2/2


GRAVEL PIT, SEE NH-PM-24 IN APPENDIX FOR RECOMMENDATION REGARDING RECLAMATION OF SAND AND GRAVEL PITS.

1/ refer to seeding mixtures and rates in table below, 2/ poorly drained soils are not desirable for use as playing area and athletic fields.

# SEEDING GUIDE

MIXIVEE	POUNDS PER ACRE	POUNDS PER 1,000 Sq. F
A. TALL FESCUE	20	0.45
CREEPING RED FESCUE	20	0.45
RED TOP	- <u>2</u>	0.05
TOTAL	42	0.95
B. TALL FESCUE	15	0.35
CREEPING RED FESCUE	10	0.25
CROWN VETCH OR	15	0,35
FLAT PEA	30	0.75
TOTAL	40 OR 55	0.95 OR 1.35
C. TALL FESCUE	20	0.45
CREEPING RED FESCUE	20	0,45
BIRDS FOOT TREFOIL	_8_	.0.20_
TOTAL	48	1,10
D. TALL FESCUE	20	0.45
FLAT PEA	.30	0.75
TOTAL.	50	1.20
E. CREEPING RED FESCUE 1/	50	1,15
KENTUCKY BLUEGRASS 1/	50	_1.35_
LATOT	100	72,30
F. TALL FESCUE 1	150	3.60
1/FOR HEAVY USE ATHLETIC FIELD NEW HAMPSHIRE COOPERATIVE EXT CURRENT VARIETIES AND SEEDING	ension turf spe	UNIVERSITY OF CIALIST FOR

# SEEDING RATES

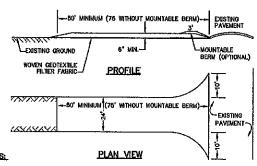

- STONE FOR STABILIZED CONSTRUCTION ENTRANCE SHALL BE 3 INCH STONE, RECLAIMED STONE, OR RECYCLED CONCRETE EQUIVALENT.

- WILLD ASPLY.

  3. THICKNESS OF THE STOKE FOR THE STABILIZED ENTRANCE SHALL NOT BE LESS THAN 6 NCHES.

  3. THICKNESS OF THE STOKE FOR THE STABILIZED ENTRANCE SHALL NOT BE LESS THAN 1 THE FULL WOTH OF THE ENTRANCE SHALL NOT BE LESS THAN 1 THE FULL WOTH OF THE ENTRANCE WHERE PROFESS OF ECRESS OCCURS, OR TO FEET, MICHELYERS OF THE STOKE STATES OF THE STATES OF
- SEDMENT WHICH IP FOODS AREH-LOF-MAN, INS MAY REQUIRE PERIODIC IN DURESHING WITH ADDITIC STONE AS CONDITIONS DEMAND AND REPAIR AND/OR CLEAN DUT OF ANY MEASURES USED TO TRANS-SEDMENT, ALL SEDMENT SPILLED, WASHED, OR TRACKED ONTO THE PUBLIC RIGHT-OF-WAY MUST BE REMOVED PROMPTLY.

# STABILIZED CONSTRUCTION ENTRANCE

NOT TO SCALE

# CONSTRUCTION SEQUENCE

- 1. A PRE CONSTRUCTION MEETING IS TO BE HELD WITH ALL DEPARTMENT HEADS PRIOR TO THE START OF CONSTRUCTIO
- 2. WETLAND BOUNDARIES ARE TO BE CLEARLY MARKED PRIOR TO THE START OF CONSTRUCTION.
- 4. INSTALL SILT FENCING, HAY BALES AND CONSTRUCTION ENTRANCES PRIOR TO THE START OF CONSTRUCTION, THESE ARE TO BE MAINTAINED UNTIL THE FINAL PAVEMENT SURFACING AND LANDSCAPING AREAS ARE ESTABLISHED.
- 5. CLEAR, CUT, GRUB AND DISPOSE OF DEBRIS IN APPROVED FACILITIES. THIS INCLUDES ANY REQUIRED DEMOLITION OF EXISTING STRUCTURES, UTILITIES, ETC.
- CONSTRUCT AND/OR INSTALL TEMPORARY SEDIMENT AND/OR DETENTION BASIN(S) AS REQUIRED. THESE FACILITIES SHALL BE INSTALLED AND STABILIZED PRIOR TO DIRECTING RUN-OFF TO THEM.
- B. PERFORM PRELIMINARY SITE GRADING IN ACCORDANCE WITH THE PLANS.
- 9. PREPARE BUILDING PAD(S) TO ENABLE BUILDING CONSTRUCTION TO BEGIN.
- 10. INSTALL UTILITIES IN ACCORDANCE WITH THE PLAN AND DETAILS, ANY CONFLICTS BETWEEN UTILITIES ARE TO BE RESOLVED WITH THE INVOLVEMENT AND APPROVAL OF THE ENGINEER.
- 11. ALL SWALES AND DRAINAGE STRUCTURES ARE TO BE CONSTRUCTED AND STABILIZED PRIOR TO HAVING RUN-OFF DIRECTED TO THEM
- DAILY, OR AS REQUIRED, CONSTRUCT TEMPORARY BERMS, DRAINAGE DITCHES, CHECK DAMS, SEDIMENT TRAPS, ETC., TO PREVENT EROSION ON THE SITE AND PREVENT ANY SILITATION OF ABILITING WATERS AND/OR PROPERTY.
- 13. PERFORM FINAL FINE GRADING, INCLUDING PLACEMENT OF 'SELECT' SUBGRADE MATERIALS.
- 15. PERFORM ALL REMAINING SITE CONSTRUCTION (I.e. BUILDING, UTILITY CONNECTIONS, ETC.).
- LOAM AND SEED ALL DISTURBED AREAS AND INSTALL ANY REQUIRED SEDIMENT AND EROSION CONTROL FACILITIES (i.e. RIP RAP, EROSION CONTROL BLANKETS, ETC.).
- 17. WORK AREA SHALL BE STABILIZED WITHIN 72 HOURS OF ACHIEVING FINISHED GRADE
- 19. COMPLETE PERMANENT SEEDING AND LANDSCAPING
- 20. REMOVE TEMPORARY EROSION CONTROL MEASURES AFTER SECONG AREAS HAVE BEEN 70%-85% ESTABLISHED AND SITE IMPROVEMENTS ARE COMPLETE. SMOOTH AND RE-VEGETATE ALL DISTURBED AREAS.
- 21. CLEAN SITE AND ALL DRAINAGE STRUCTURES OF ALL SILT AND DEBRIS
- 23. ALL EROSION CONTROLS SHALL BE INSPECTED WEEKLY AND AFTER EVERY HALF-INCH OF RAINFALL
- 24. UPON COMPLETION OF CONSTRUCTION, IT IS THE RESPONSIBILITY OF THE CONTRACTOR TO NOTIFY ANY RELEVANT PERMITTING AGENCIES THAT THE CONSTRUCTION HAS BEEN FINISHED IN A SATISFACTORY MANNER.

	- artillane.						
Design: JAC   Draft: DJM   Date: 10/30/20	WHITE STEW HAR	1 6 1	6/1/21	REVISEO PER CONDITIONS OF APPROVAL	DJM		
Checked: JAC   Scale: AS NOTED   Project No.: 20656.1	7 80		-7-7-7			Designed and Produced in NH	Plan Name: ERC
Drawing Name: 20656-PLAN.dwg		1 4	4/9/21	REVISED PER ENGINEERING AND PLANNING DEPT COMMENTS	DJM		Light Martie: CMC
	MICHAEL NO CO	- 3	3/29/21	REVISED PER ENGINEERING COMMENTS	DJM	Jones & Beach Engineers, Inc.	
THIS PLAN SHALL NOT BE MODIFIED WITHOUT WRITTEN	重好		0,20,21	TRATIOLD I ELI ENGINALLI GIOGOLIANI LA TO	POIN	The state of Designation of the state of the	
PERMISSION FROM JONES & BEACH ENGINEERS, INC. (JBE).	KERIVAN OF	- 2	3/11/21	REVISED PER PLANNING BOARD COMMENTS	ÐJM		Project:
ANY ALTERATIONS, AUTHORIZED OR OTHERWISE, SHALL BE	No. 9040	·	nation.		-	85 Portsmouth Ave. Civil Engineering Services 603-772-4746	1 '
	Solvenson A S	. 1	2/9/21	ISSUED FOR REVIEW	DJM	PO Box 219 FAX: 603-772-0227	
AT THE USER'S SOLE RISK AND WITHOUT LIABILITY TO JBE.		REV.	DATE	REVISION	BY		Owner of Record:
	LEST WOMAN POST OF	MCA.	DATE	HEADIOIA	14	Stratham, NH 03885 E-MAIL: JBE@JONESANDBEACH.COM	Office of Hecolds

ROSION AND SEDIMENT CONTROL DETAILS VENTURE POWERSPORTS 7 TOLEND ROAD, BARRINGTON, NH PEH AND SON, LLC 17 DUDLEY ROAD, BRENTWOOD, NH 03833 BK 4855 PG 0723

SHEET 12 OF 12 JBE PROJECT NO. 20656.

DRAWING No